





- NOTES:**
1. DIVERSION SWALES AND ROCK CHECK DAMS ARE PRESENTLY IN PLACE AT THE APPROXIMATE LOCATIONS SHOWN. THE CONTRACTOR SHALL MAINTAIN THE EXISTING AND NEW EROSION CONTROL STRUCTURES UNTIL STABILIZATION HAS OCCURRED. BEFORE FINAL PROJECT ACCEPTANCE, THE CONTRACTOR SHALL REPAIR EROSION CONTROL STRUCTURES THAT ARE TO REMAIN AFTER STABILIZATION TO THEIR ORIGINAL CONDITIONS. SILT FENCE SHALL BE REMOVED AFTER STABILIZATION. DIVERSION SWALE REMOVAL SHALL CONSIST OF COMPACTED TOPSOIL FOLLOWED BY REGRASSING WITH "STANDARD" HYDROMULCH MIXTURE.
 2. REFER TO PLANTING PLAN, SHEET L-1.

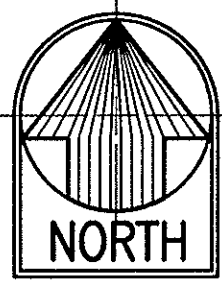

AREA A
SCALE: 1"=50'

LEGEND:

- GROUND TOPOGRAPHIC SURVEY
- PROPOSED GRADING
- DIVERSION SWALE WITH ROCK CHECK DAM
- DIVERSION SWALE
- ROCK CHECK DAM
- SILT FENCE

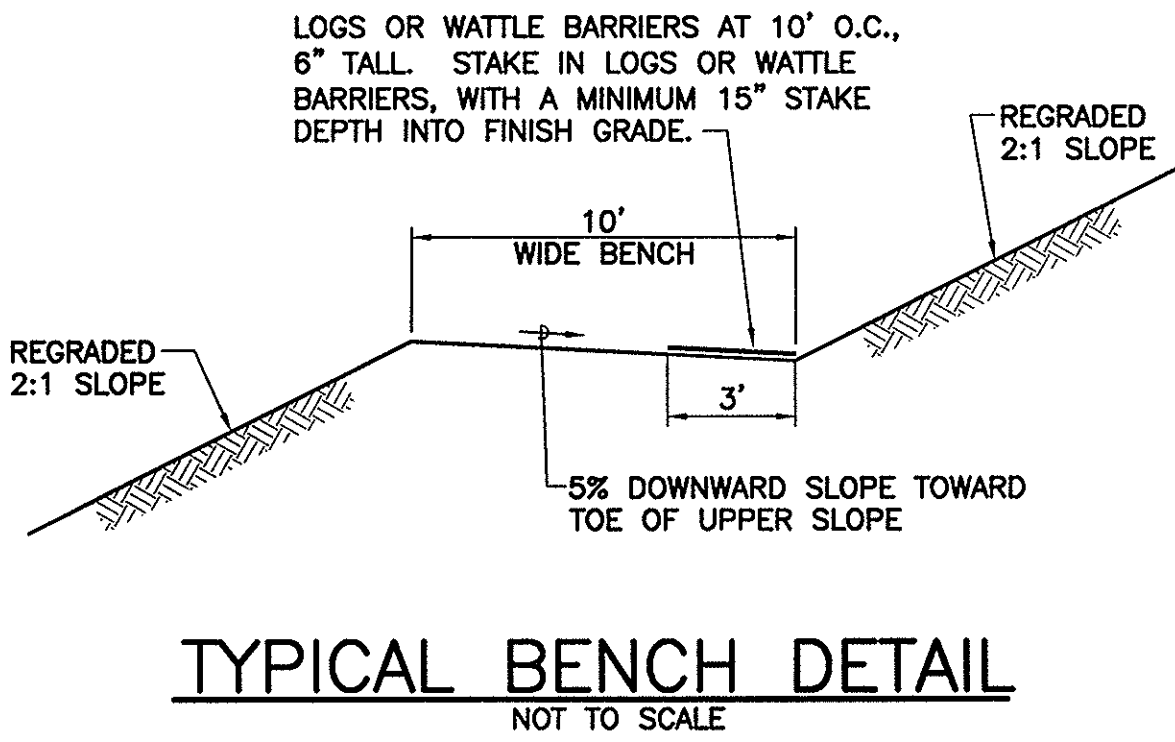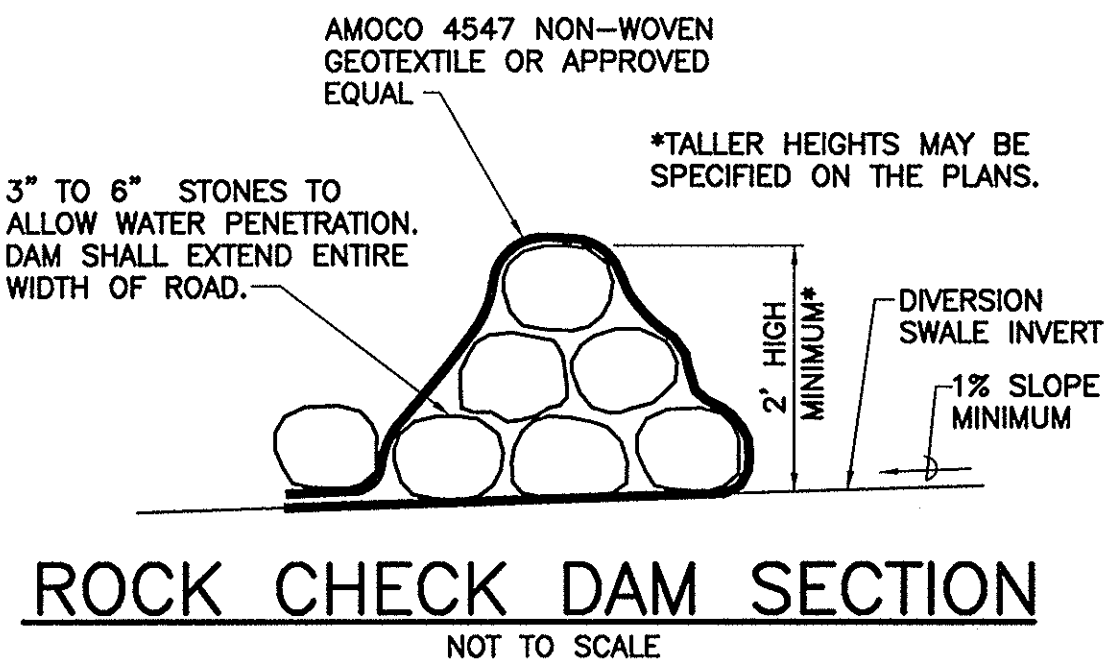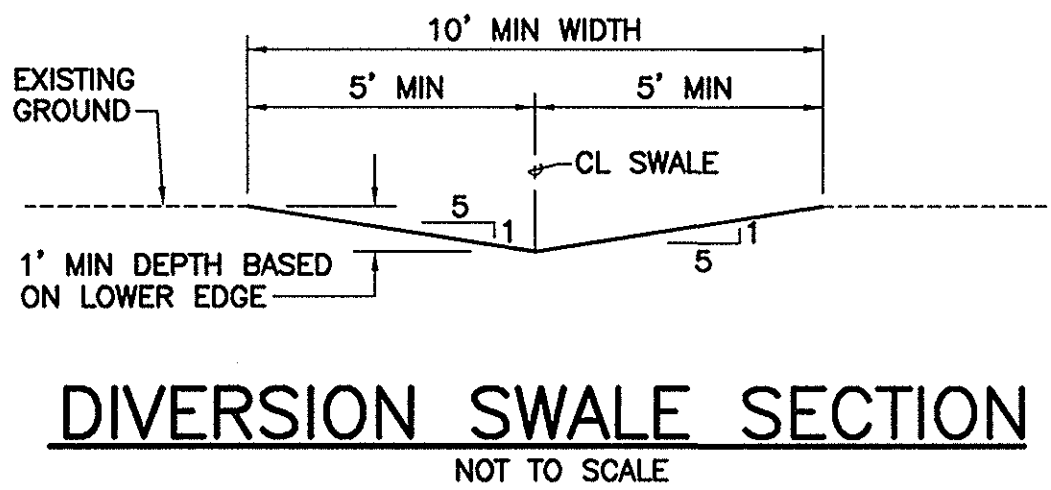

Rev	Date	Description	Eng	App
CONSENT DECREE VERSION: DECEMBER 16, 2005				

THIS WORK WAS PREPARED BY ME OR UNDER MY SUPERVISION AND CONSTRUCTION OF THIS PROJECT WILL BE UNDER MY OBSERVATION.

APRIL 30, 2004
EXPIRATION DATE OF THE LICENSE

Paul Wallrabenstein
LICENSED PROFESSIONAL ENGINEER
No. 2435-C
HAWAII, U.S.A.

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Landscape Architecture
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Consultant:

Client:

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1450 South Beretania Street
Honolulu, Hawaii 96814

**PILA'A 400
REMEDIATION PLAN - PACKAGE 1
GRADING PLAN
AREA A**

Designed By: C.K.L. Drawn By: J.T., G.Y.
Project No: 2002.33.2600 (D01) Date: AUGUST, 2003

Approved By: _____

RECORD COPY
JUL - 7, 2004

FILE	POCKET	FOLDER	NO.
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